

FIRE ALARM LEGEND

SMOKE DETECTOR COVERAGE HEAT DETECTOR COVERAGE



### NOTES

- ALL DIMENSIONS & LEVELS ARE IN "MM" OR OTHERWISE SPECIFIED.

  COMPLY WITH THE REQUIREMENTS OF NFPA 72.


  FIRE ALARM DEVICES TO BE SAME / RECOMMENDED MAKE USED AT AIRPORT TO AVOID COMPATIBILITY ISSUES.

  FIRE ALARM SYSTEM LOOP CABLE TO BE SAME SIZE & TYPE AS USED BY AIRPORT
- AIRPORT.

  RESPONSE INDICATOR (RI) TO BE PROVIDED AT FALSE CEILING FOR ABOVE CEILING DETECTORS.

### **ABBREVIATIONS**

BFV - BUTTERFLY VALVE
 WFS - WATER FLOW SWITCH

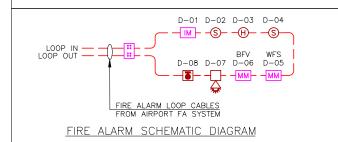

FIRE ALARM DETEOFOR COVERAGE

ALL DIMENSIONS MUST BE CHECKED ON SITE.
INFORM THE ENGINEER OF ANY DISCREPANCIES PRIOR TO CONSTRUCTION.

NOTES:
IRRESPECTIVE OF THE DRAWINC(S), IT IS THE CONTRACTOR'S OBLIGATION AND RESPONSIBILITY THAT SHALL BE EXECUTED AND COMPLETED IN ACCORDANCE TO THE SPECIFICATION, DRAWING(S) AS WELL AS REQUIREMENT. THE SAUD DRAWING(S) SHALL NOT RELIEVE CONTRACTOR FROM ANY OBLICATION UNDER THE CONTRACTOR AND IN PARTICULAR FROM ITS RESPONSIBILITY IN RELATION TO THE INSTALLATION MATERIALS AND WORKMANSHIP AND WHERE RELEVANT FROM A DUTY TO SEEK APPROVAL FROM THE COMPETENT AUTHORITY.

C00 06.03.24 GOOD FOR CONSTRUCTION

REV DATE DESCRIPTION

DRN CHK





PROJECT FF025

MILIIE COOKIES HYDERABAD AIRPORT

DRAWING TITLE

FIRE ALARM LAYOUT


SCALE 1:75 DATE 06.03.24 DRAWN AK A3 SHEET

**GOOD FOR CONSTRUCTION** 

PROJECT NO DRAWING TYPE NUMBER

TFS XXXX ELEC F101 C00




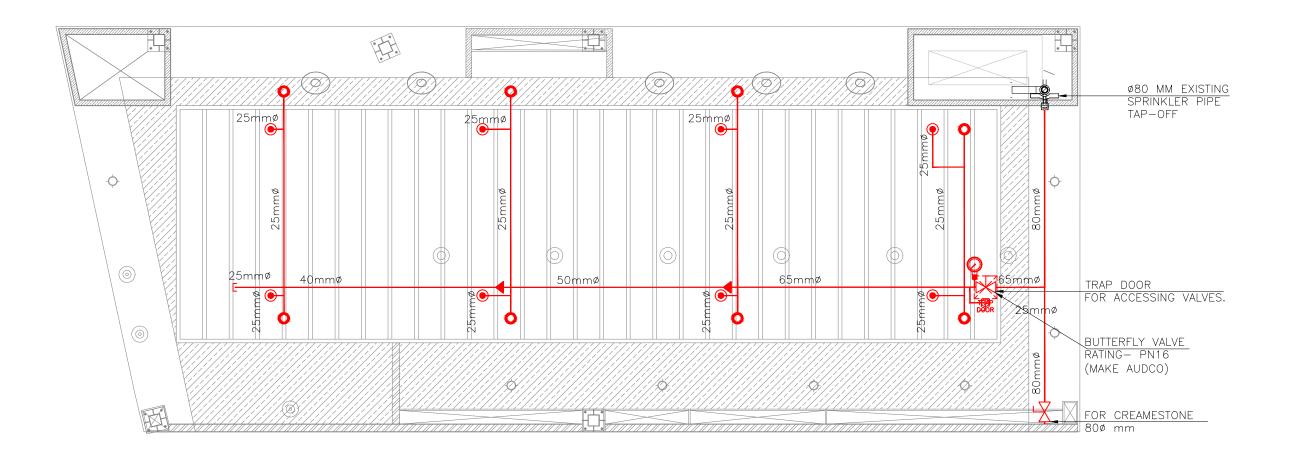

### **101 FIRE SPRINKLER LAYOUT - PENDENT AND UPRIGHT**

FIRE SPRINKLER SYSTEM LEGEND				
SYMBOL	DESCRIPTION	QTY		
<b>-o</b> -	SPRINKLER HEAD UPRIGHT	08		
-	SPRINKLER HEAD PENDENT	08		
->-	SPRINKLER BUTTERFLY VALVE (ISOLATION VALVE)	02		
FS	SPRINKLER PIPE FLOW SWITCH	01		
	SPRINKLER PIPE			
	SPRINKLER PIPE EXISTING			
-	SPRINKLER PIPE REDUCER			
<b>Q</b>	PRESSURE GAUGE	01		
<u>—</u> ā—	SPRINKLER BALL VALVE — TEST DRAIN	01		
TRAP DOOR	ACCESS DOOR - 300 x 300	01		

- INSTALLATION WORKS FOR THE AUTOMATIC SPRINKLERS SYSTEM SHALL COMPLY WITH THE REQUIREMENTS OF NPFA 13.
- ISOLATION VALVE SHALL BE CONSIDERED AT SPRINKLER TAPPING (PN16) AND TRAP DOOR SHALL BE PROVIDED FOR THE SAME FOR EASY MAINTENANCE.
- M.S "C" CLASS PIPES SHALL BE USED FOR THE FF PIPES.
- DRAIN PIPE WITH BALL VALVE TO BE PROVIDED AFTER THE ISOLATION VALVE FOR MAINTENANCE PURPOSE AS PER SITE CONDITION.
- ALL FIRE SPRINKLER PENDANT SHALL HAVE A COVERAGE AREA OF APPROXIMATELY 24 SQ.METER.
- PRESSURE GAUGE TO BE PROVIDED AFTER ISOLATION VALVE.

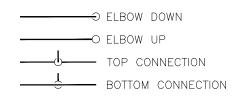

ALL DIMENSIONS MUST BE CHECKED ON SITE INFORM THE ENGINEER OF ANY DISCREPANCIES PRIOR TO CONSTRUCTION

NOTES:
IRRESPECTIVE OF THE DRAWING(S), IT IS THE CONTRACTOR'S OBLIGATION AND RESPONSIBILITY THAT SHALL BE EXECUTED AND COMPLETED IN ACCORDANCE TO THE SPECIFICATION, DRAWING(S) AS WELL AS REQUIREMENT. THE SALD DRAWING(S) SHALL NOT REQUEE CONTRACTOR FROM ANY OBLIGATION UNDER THE CONTRACTOR FROM ANY OBLIGATION UNDER THE CONTRACT AND IN PARTICULAR FROM ITS RESPONSIBILITY IN PELIATION TO THE MISTALLATION MATERIALS AND WORKMANSHIP AND WHERE RELEVANT FROM A DUTY TO SEEK APPROVAL FROM THE COMPETENT AUTHORITY.

CO1 06.03.24 GOOD FOR CONSTRUCTION REV DATE DESCRIPTION

DRN CHK





PROJECT

FF-025 MILIIE COOKIES HYDERABAD AIRPORT

DRAWING TITLE


FIRE SPRINKLER LAYOUT PENDENT AND UPRIGHT

SCALE 1:50 DATE 06.03.24 DRAWN ST A3 SHEET

GOOD FOR CONTRUCTION

PROJECT NO DRAWING TYPE NUMBER


TFS XXXX FIRE F201 C01

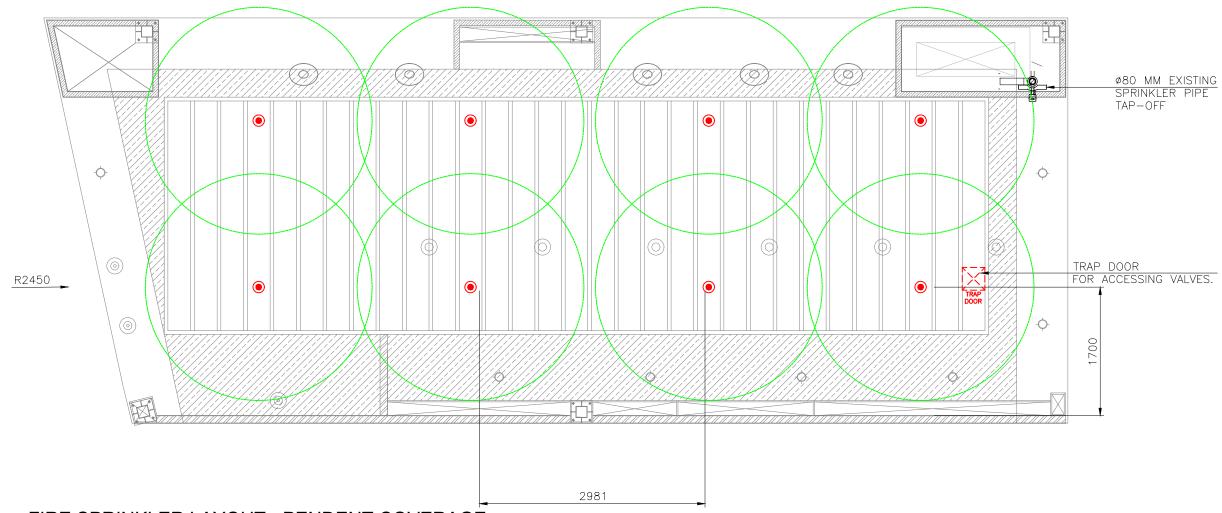

## O1 FIRE SPRINKLER LAYOUT - PENDENT COVERAGE

	FIRE SPRINKLER SYSTEM LEGEND	
SYMBOL	DESCRIPTION	QTY
<b>-o</b> -	SPRINKLER HEAD UPRIGHT	08
	SPRINKLER HEAD PENDENT	08
->-	SPRINKLER BUTTERFLY VALVE (ISOLATION VALVE)	02
FS	SPRINKLER PIPE FLOW SWITCH	01
	SPRINKLER PIPE	
	SPRINKLER PIPE EXISTING	
-	SPRINKLER PIPE REDUCER	
<b>Q</b>	PRESSURE GAUGE	01
<u>—</u> ā—	SPRINKLER BALL VALVE — TEST DRAIN	01
I TRAP DOOR	ACCESS DOOR - 300 x 300	01

- INSTALLATION WORKS FOR THE AUTOMATIC SPRINKLERS SYSTEM SHALL COMPLY WITH THE REQUIREMENTS OF NPFA 13.
- ISOLATION VALVE SHALL BE CONSIDERED AT SPRINKLER TAPPING (PN16) AND TRAP DOOR SHALL BE PROVIDED FOR THE SAME FOR EASY MAINTENANCE.
- M.S "C" CLASS PIPES SHALL BE USED FOR THE FF PIPES.
  DRAIN PIPE WITH BALL VALVE TO BE PROVIDED AFTER THE ISOLATION VALVE FOR MAINTENANCE PURPOSE AS PER SITE CONDITION.
- ALL FIRE SPRINKLER PENDANT SHALL HAVE A COVERAGE AREA OF APPROXIMATELY 24 SQ.METER.
- PRESSURE GAUGE TO BE PROVIDED AFTER ISOLATION VALVE.

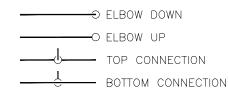

ALL DIMENSIONS MUST BE CHECKED ON SITE INFORM THE ENGINEER OF ANY DISCREPANCIES PRIOR TO CONSTRUCTION

NOTES:
IRRESPECTIVE OF THE DRAWING(S), IT IS THE CONTRACTOR'S OBLIGATION AND RESPONSIBILITY THAT SHALL BE EXECUTED AND COMPLETED IN ACCORDANCE TO THE SPECIFICATION, DRAWING(S) AS WELL AS REQUIREMENT. THE SALD DRAWING(S) SHALL NOT RELIEVE CONTRACTOR FROM ANY OBLIGATION UNDER THE CONTRACTOR FROM ANY OBLIGATION UNDER THE CONTRACT AND IN PARTICULAR FROM THE RESPONSIBILITY IN PERLATION TO THE INSTALLATION MATERIALS AND WORKMANSHIP AND WHERE RELEVANT FROM A DUTY TO SEEK APPROVAL FROM THE COMPETENT AUTHORITY.

CO1 06.03.24 GOOD FOR CONSTRUCTION REV DATE DESCRIPTION

DRN CHK





PROJECT

FF-025 MILIIE COOKIES HYDERABAD AIRPORT

DRAWING TITLE


FIRE SPRINKLER LAYOUT PENDENT COVERAGE

SCALE 1:50 DATE 06.03.24 DRAWN ST A3 SHEET

GOOD FOR CONTRUCTION

PROJECT NO DRAWING TYPE NUMBER

TFS XXXX FIRE F202 C01

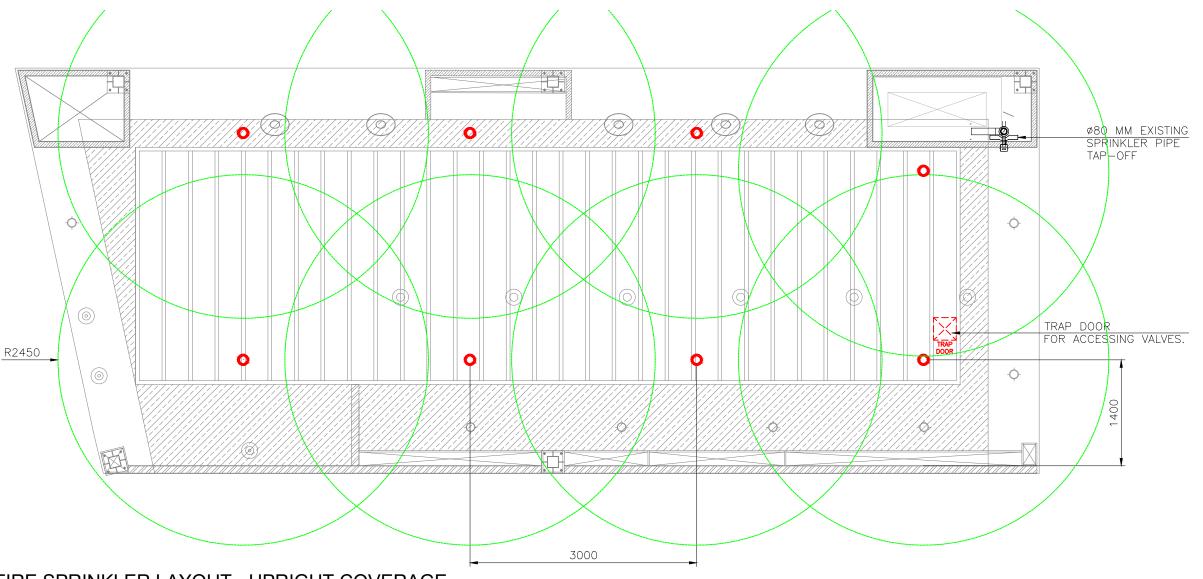

## O1 FIRE SPRINKLER LAYOUT - UPRIGHT COVERAGE

	FIRE SPRINKLER SYSTEM LEGEND	
SYMBOL	DESCRIPTION	QTY
<b>-o</b> -	SPRINKLER HEAD UPRIGHT	08
	SPRINKLER HEAD PENDENT	08
>-	SPRINKLER BUTTERFLY VALVE (ISOLATION VALVE)	02
FS	SPRINKLER PIPE FLOW SWITCH	01
	SPRINKLER PIPE	
	SPRINKLER PIPE EXISTING	
-	SPRINKLER PIPE REDUCER	
<b>©</b>	PRESSURE GAUGE	01
<u>—</u> ā—	SPRINKLER BALL VALVE — TEST DRAIN	01
I TRAP J	ACCESS DOOR - 300 x 300	01

- INSTALLATION WORKS FOR THE AUTOMATIC SPRINKLERS SYSTEM SHALL COMPLY WITH THE REQUIREMENTS OF NPFA 13.
- ISOLATION VALVE SHALL BE CONSIDERED AT SPRINKLER TAPPING (PN16) AND TRAP DOOR SHALL BE PROVIDED FOR THE SAME FOR EASY MAINTENANCE.
- M.S "C" CLASS PIPES SHALL BE USED FOR THE FF PIPES.
  DRAIN PIPE WITH BALL VALVE TO BE PROVIDED AFTER THE ISOLATION VALVE FOR MAINTENANCE PURPOSE AS PER SITE CONDITION.
- ALL FIRE SPRINKLER PENDANT SHALL HAVE A COVERAGE AREA OF APPROXIMATELY 24 SQ.METER.
- PRESSURE GAUGE TO BE PROVIDED AFTER ISOLATION VALVE.



ALL DIMENSIONS MUST BE CHECKED ON SITE INFORM THE ENGINEER OF ANY DISCREPANCIES PRIOR TO CONSTRUCTION

NOTES:
IRRESPECTIVE OF THE DRAWING(S), IT IS THE CONTRACTOR'S OBLIGATION AND RESPONSIBILITY THAT SHALL BE EXECUTED AND COMPLETED IN ACCORDANCE TO THE SPECIFICATION, DRAWING(S) AS WELL AS REQUIREMENT. THE SALD DRAWING(S) SHALL NOT RELIEVE CONTRACTOR FROM ANY OBLIGATION UNDER THE CONTRACTOR FROM ANY OBLIGATION UNDER THE CONTRACT AND IN PARTICULAR FROM THE RESPONSIBILITY IN PERLATION TO THE INSTALLATION MATERIALS AND WORKMANSHIP AND WHERE RELEVANT FROM A DUTY TO SEEK APPROVAL FROM THE COMPETENT AUTHORITY.

CO1 06.03.24 GOOD FOR CONSTRUCTION

REV DATE DESCRIPTION

DRN CHK





FF-025 MILIIE COOKIES HYDERABAD AIRPORT

DRAWING TITLE

SCALE 1:50

FIRE SPRINKLER LAYOUT UPRIGHT COVERAGE


GOOD FOR CONTRUCTION

DATE 06.03.24

PROJECT NO DRAWING TYPE NUMBER TFS XXXX FIRE F203 C01

DRAWN ST

A3 SHEET

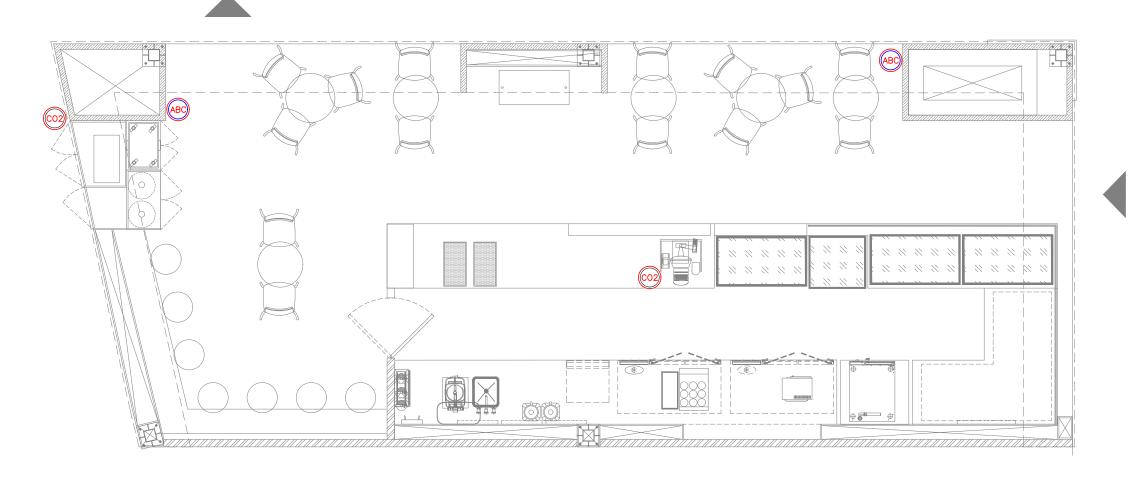

# O1 FIRE EXTINGUISHER LAYOUT

FIRE EXTINGUISHERS LEGEND				
SYMBOL	DESCRIPTION	QTY		
ABC	FIRE EXTINGUISHER_CLASS ABC (DRY POWDER) - 4 KG	02		
CO2	FIRE EXTINGUISHER_CLASS BC (CO2) - 3.0 KG	02		

- FIRE EXTINGUISHER SHALL BE INSTALLED IN LOCATION WHERE THEY ARE VISIBLE
- FIRE EXTINGUISHER SHALL BE CONSPICUOUSLY LOCATED WHERE THEY ARE READILY ACCESSIBLE AND IMMEDIATELY AVAILABLE IN THE EVENT OF FIRE.
- FIRE EXTINGUISHER SHALL BE INSTALLED SO THAT THE FIRE EXTINGUISHER'S OPERATING INSTRUCTIONS FACE OUTWARD.
- FIRE EXTINGUISHER SHALL BE INSTALLED SO THAT IN NO CASES THE TOP OF THE EXTINGUISHER IS NOT MORE THAT 1500MM ABOVE THE FLOOR LEVEL OR THE CLEARANCE BETWEEN THE BOTTOM OF THE HAND PORTABLE FIRE EXTINGUISHER AND THE FLOOR BE LESS THAN 100MM.
- SIGNS OR OTHER MEANS USED TO INDICATE FIRE EXTINGUISHER LOCATION SHALL BE LOCATED IN CLOSE PROXIMITY TO THE EXTINGUISHER AND SHALL BE VISIBLE FROM THE NORMAL PATH OF TRAVEL.
- ALL FIRE EXTINGUISHER SIGNS TO BE PROVIDED WITH NIGHT GLOW.

ALL DIMENSIONS MUST BE CHECKED ON SITE INFORM THE ENGINEER OF ANY DISCREPANCIES PRIOR TO CONSTRUCTION

NOTES:
IRRESPECTIVE OF THE DRAWING(S), IT IS THE CONTRACTOR'S OBLIGATION AND RESPONSIBILITY THAT SHALL BE EXECUTED AND COMPLETED IN ACCORDANCE TO THE SPECIFICATION, DRAWING(S) AS WELL AS REQUIREMENT. THE SAID DRAWING(S) SHALL NOT RELIEVE CONTRACTOR FROM ANY OBLIGATION UNDER THE CONTRACTOR AND IN PARTICULAR FROM ITS RESPONSIBILITY IN RELATION TO THE INSTALLATION MATERIALS AND WORKMANSHIP AND WHERE RELEVANT FROM A DUTY TO SEEK APPROVAL FROM THE COMPETENT AUTHORITY.

C00 27.02.24 GOOD FOR CONSTRUCTION

REV DATE DESCRIPTION

DRN CHK

A3 SHEET





PROJECT

FF-025 MILIIE COOKIES HYDERABAD AIRPORT

DRAWING TITLE

FIRE EXTINGUISHER LAYOUT

SCALE 1:50 DATE 27.02.24 DRAWN ST

GOOD FOR CONTRUCTION

PROJECT NO DRAWING TYPE NUMBER

TFS XXXX FIRE F301 C00